



Notes

1. This drawing has been prepared in accordance with the scope of RPS's appointment with its client and is subject to the terms and conditions of that appointment. RPS accepts no liability for any use of this document other than by its client and only for the purposes for which it was prepared and provided.
2. If received electronically it is the recipients responsibility to print to correct scale. Only written dimensions should be used.
3. This drawing should be read in conjunction with all other relevant drawings and specifications.

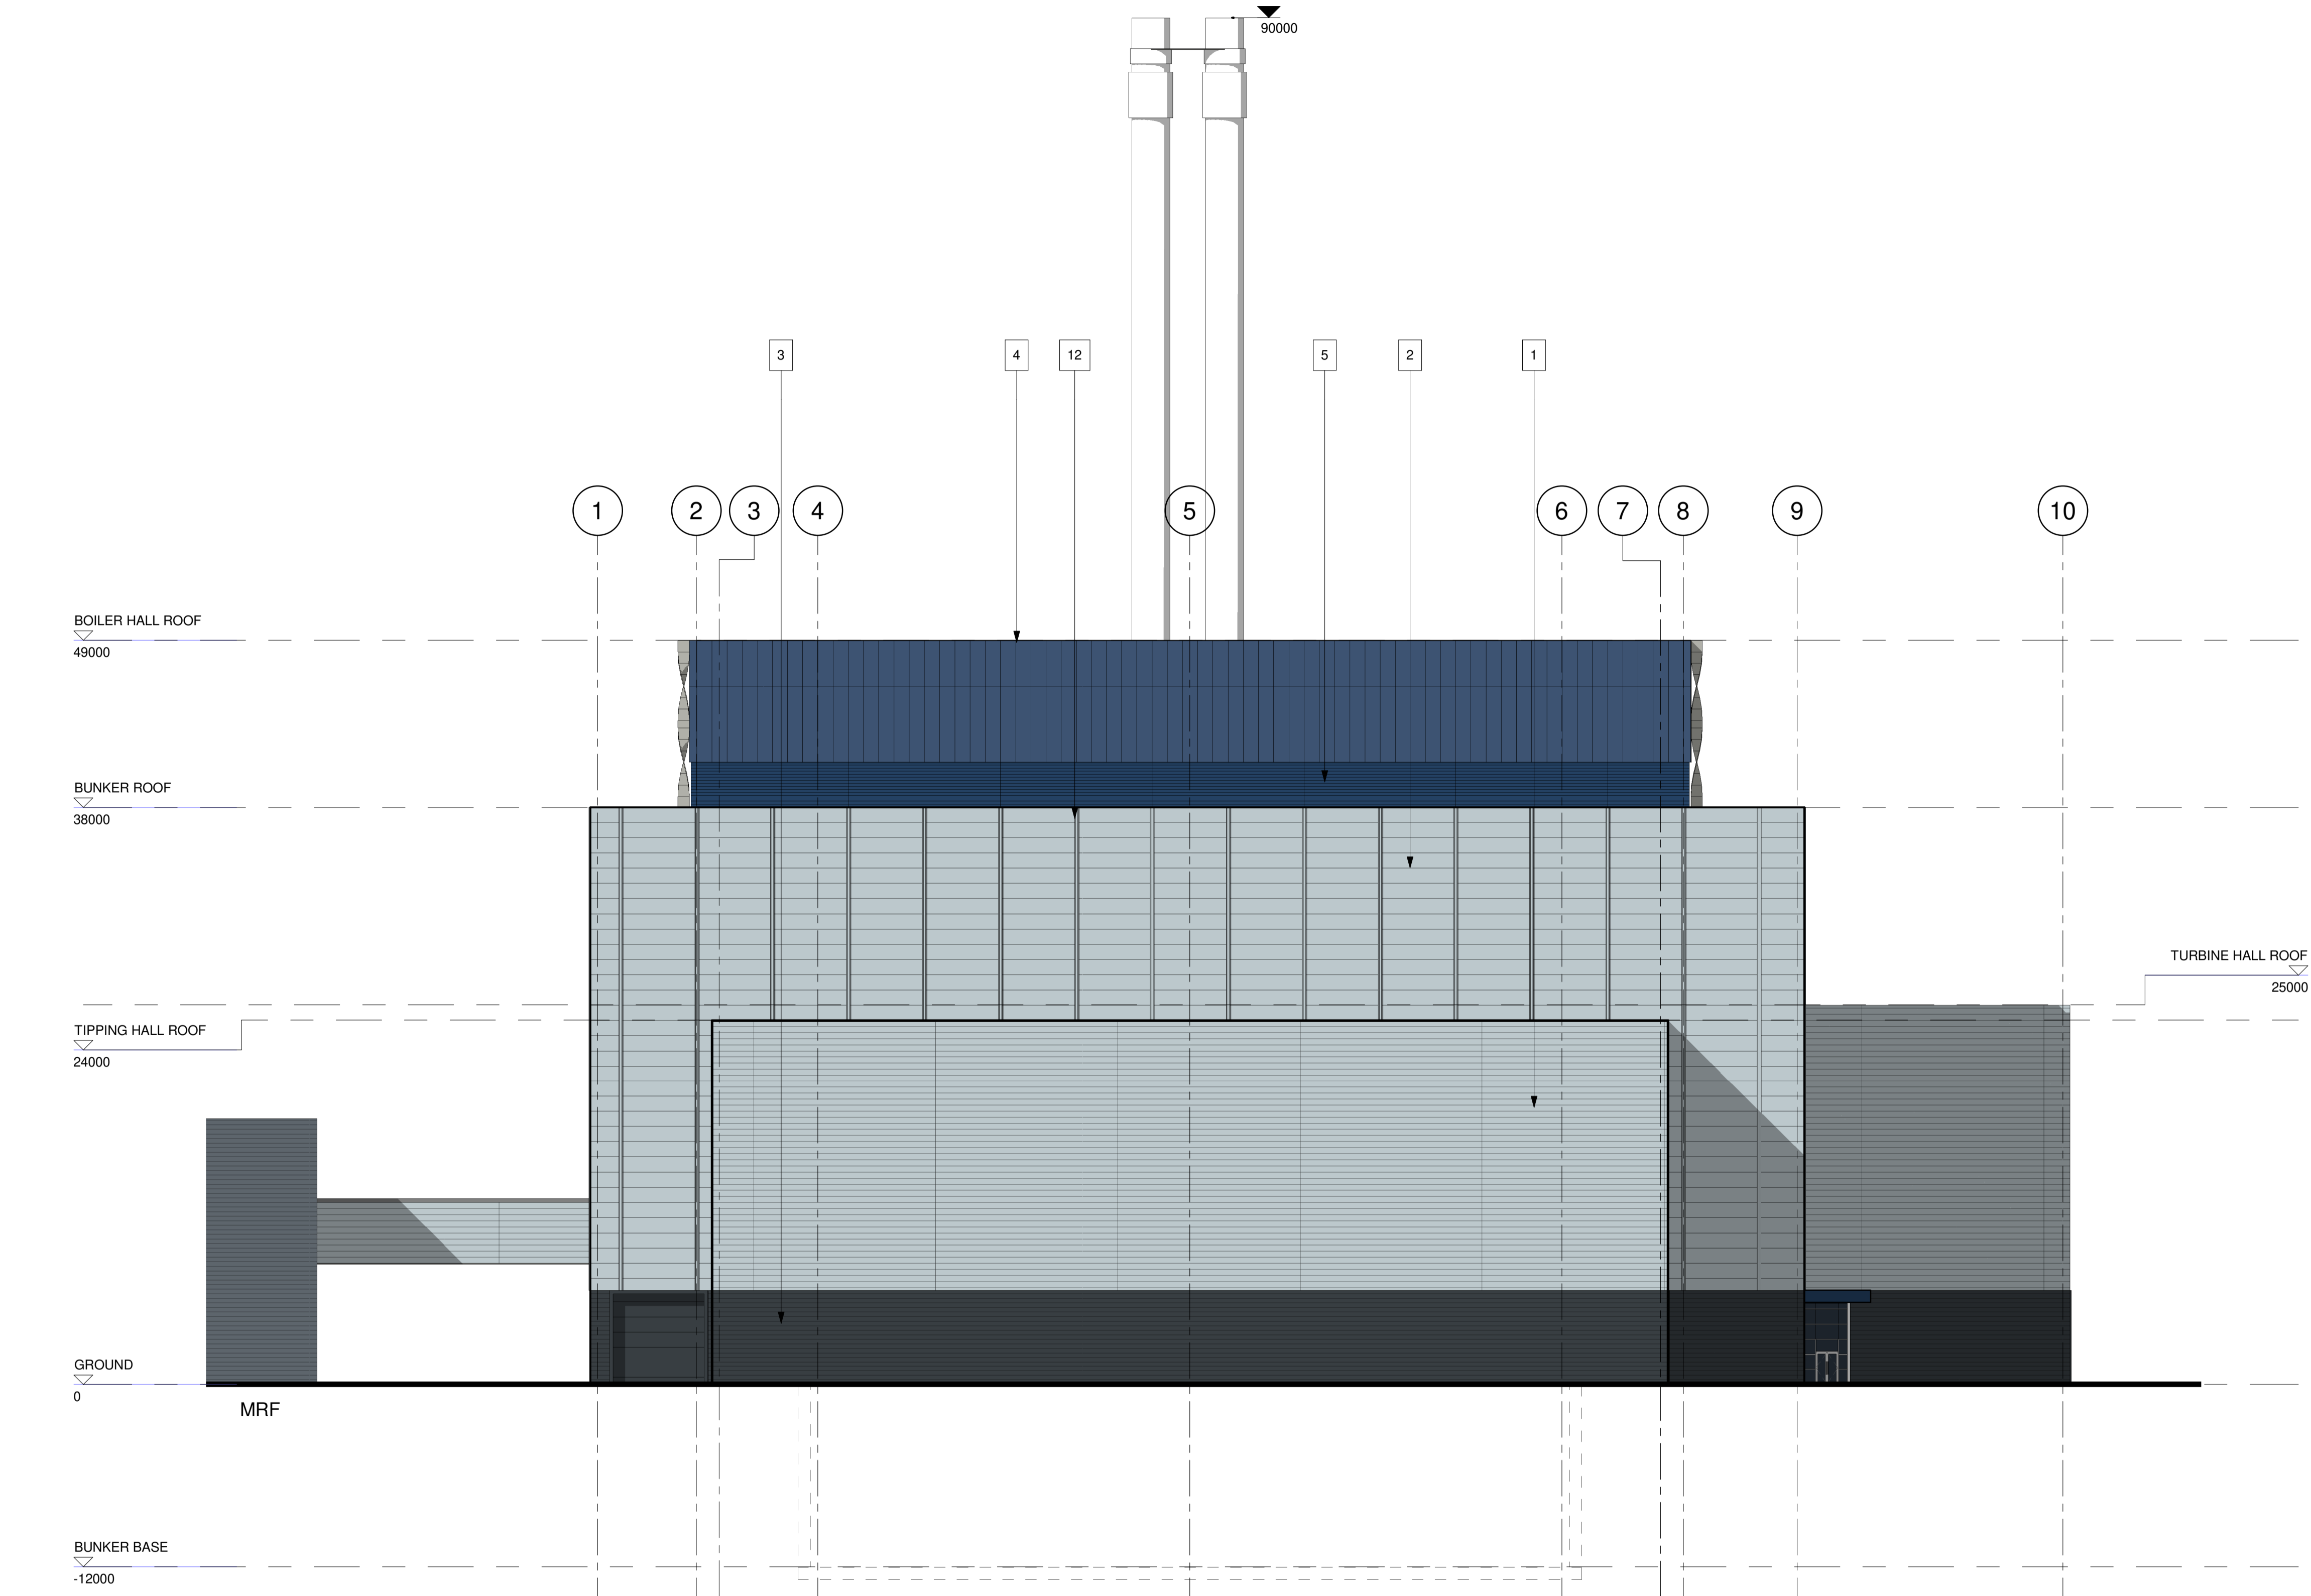

Proposed South Elevation  
1 : 250

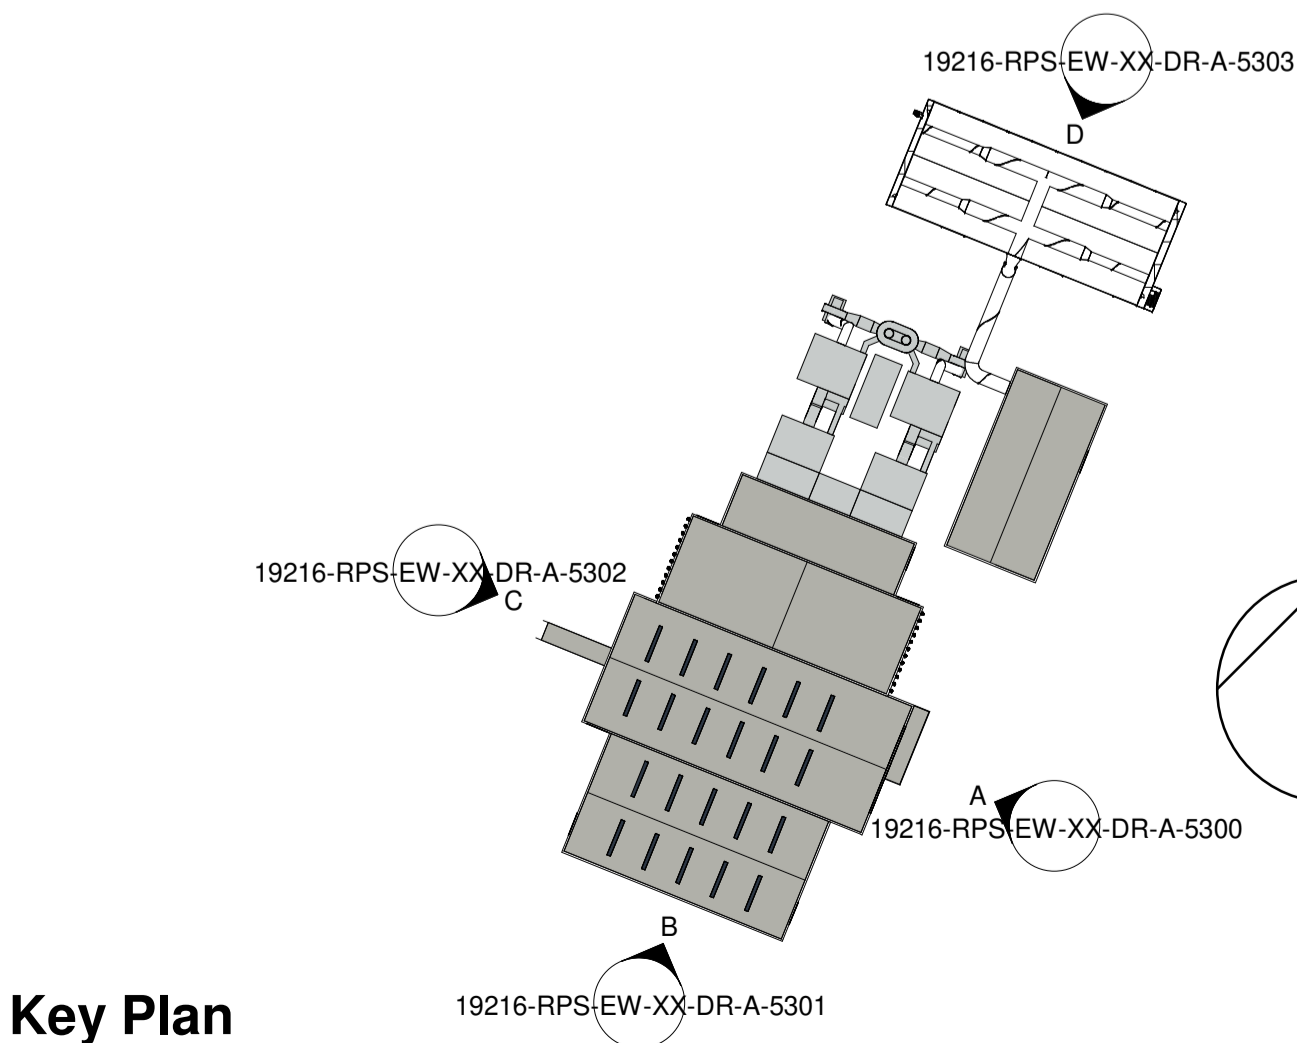

Key Plan  
1 : 2000

Key

1. Trapezoidal cladding, horizontally laid, Colour Light Blue.
2. Flat panel cladding, Horizontally laid, Colour Light Blue.
3. Trapezoidal cladding, Horizontally laid, Colour Dark Grey
4. Translucent Cladding, Vertically laid, Colour Dark Blue
5. Louvre, Colour Dark Blue
6. Louvre, Colour Light Blue,
7. Curtain Walling
8. Office glazing
9. Roller Shutter Door, Colour Dark Grey
10. Canopy, Dark Blue
11. Fins, Colour Light Grey
12. Face fixed Flashing, Colour Light Blue
13. Perforated cladding, Colour Light Blue

5m SCALE 1:250

P01	Initial Issue for comment	ET	TFH	14/02/2020
Rev	Description	By	Ckd	Date



Suite D10, Josephs Well, Hanover Walk  
Leeds, West Yorkshire LS3 1AB, United Kingdom  
T:0113 220 6190 Expsnewark@rpsgroup.com

Client

Project Redcar Energy Centre

Title Proposed REC South Elevation

Status	Scale @ A1	Date Created
Preliminary	As indicated	04/02/20
Task Team Manager	Information Author	Task Information Manager
TFH	ET	NB

Document Number  
19216-RPS-EW-XX-DR-A-5301

Project Code - Originator - Zone - Level - Type - Role - Drawing Number

RPS Project Number	Suitability	Revision
NK019216	S0	P01
rpsgroup.com		